STANDARD	DESCRIPTION	DRAWING
LT 001-01	DRAWING INDEX (This sheet)	C-ES-001-00
LT 002-01	ELECTRICAL LEGEND	C-ES-001-01
LT 010-01	COLUMN OPTIONS	C-ES-100-01
LT 010-02	COLUMN OPTIONS	C-ES-100-02
LT 020-01	LIGHTING/TRAFFIC COLUMNS Footing Details	C-ES-101-01
LT 030-01	POST TOP Location Details Typical	C-ES-120-01
LT 030-02	STREET LIGHTING Location Details Typical	C-ES-120-02
LT 110-01	3.5M POST TOP Ceremonial Column	C-ES-122-01
LT 110-02	3.5M POST TOP Ceremonial Details	C-ES-122-02
LT 110-03	3.5M POST TOP Ceremonial Base	C-ES-122-03
LT 120-01	3.5M POST TOP Streets/Park Lands	C-ES-121-01
LT 130-01	3.5M POST TOP Heritage	C-ES-123-01
LT 221-01	WALL MOUNTED	C-ES-160-01
LT 221-02	WALL MOUNTED Cable Protection	C-ES-160-02
LT 300-00	UNDERGROUND ELECTRICAL ENCLOSURE Pit	C-ES-133-00
LT 300-01	UNDERGROUND ELECTRICAL ENCLOSURE Cover	C-ES-133-01
LT 310-01	UNDERGROUND ELECTRICAL ENCLOSURE Type 1	C-ES-133-02
LT 310-02	UNDERGROUND ELECTRICAL ENCLOSURE Type 2	C-ES-133-03
LT 310-03	UNDERGROUND ELECTRICAL ENCLOSURE Internal Board Options	C-ES-133-04
LT 400-01	6.5 M COLUMN	C-ES-102-01
LT 400-02	6.5 M COLUMN with Traffic Light Attachments	C-ES-102-02
LT 410-01	9.0 M COLUMN	C-ES-103-01
LT 410-02	9.0 M COLUMN with Traffic Light Attachments	C-ES-103-02
LT 420-01	10.5 M COLUMN	C-ES-104-01
LT 420-02	10.5 M COLUMN with Traffic Light Attachments	C-ES-104-02
LT 421-01	10.5 M COLUMN Double Outreach	C-ES-105-01
LT 700-01	SINGLE LIGHTING COLUMN Direct Supply from ETSA Pit	C-ES-130-01
LT 700-02	MULTIPLE LIGHTING COLUMNS	C-ES-131-01
LT 800-01	UNDERGROUNDING OF PRIVATE PROPERTIES Plan and Schedule	C-ES-150-01
LT 800-02	UNDERGROUNDING OF PRIVATE PROPERTIES Details	C-ES-150-02
LT 900-01	TRENCHES Streets	C-ES-140-01
LT 900-02	TRENCHES Park Lands	C-ES-141-01
LT 900-03	BORED TRENCHES Park Lands	C-ES-141-02

DESIGNED PK/TL	CHECKED TL
DRAWN JR/JB	CERTIFIED RS
	DATE 05/2001
C_lt_ijt_yprojects	SCALE N.T.S.
	DRWG No. C-ES-001-00

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CONSTRUCTION STANDARD Lighting and Electrical DRAWING INDEX

STANDARD NUMBER SHEET No. LT 001 This document produced by City of Adelaide shall not copied without written consent.

DESCRIPTION EXISTING PROPOSED (THIN PEN - 0.18mm) (THICK PEN - 0.5mm) ETSA OVERHEAD CABLES ETSA UNDERGROUND SERVICE DUCTS/CABLES \times SP \times ACC SPARE CONDUIT ACC PUBLIC LIGHTING CONDUIT \times L \times \times C \times $-\times$ c $-\times$ CONSUMER SERVICE CONDUIT COMMON TRENCH CONDUITS \times CT \times -X--CT--X- ACC TRAFFIC SIGNAL DUCT —TS-___P___P___ PRIVATE COMMUNICATIONS CARRIER **TELSTRA** GAS — G -____ G ____ SEWER WATER KERB LINE STOBIE POLE STOBIE POLE TO BE REMOVED CONSUMER METER SWITCHBOARD CMS 🗵 CMS 🔼 FΟ F 🚳 ETSA SERVICE FUSE ENCLOSURE SP O SP 🚳 ETSA SERVICE PIT ETSA FUSE PIT ETSA Ø ETSA @ ACC Ø ACC 🕢 ACC FUSE PIT ACC ♥ ACC(E) ACC FUSE PIT WITH EARTH STAKE ACC 🗵 MSB **∠** ACC UNDERGROUND PUBLIC LIGHTING SWITCHBOARD PT O 3.5M POST TOP LANTERN PT 🚳 LIGHTING COLUMN (6.5M, 9.0M OR 10.5M AS NOTED) SB ⊶ SB **⊶**O LIGHTING COLUMN (WITH COLUMN MOUNTED SWITCHBOARD) LIGHTING COLUMN - DOUBLE OUTREACH \bigcirc \bigcirc **──X** LIGHTING COLUMN TO BE REMOVED ABOVE GROUND LEVEL A.G.L. A.G.L.

PNIL	CHECKED	IL		Lighting an		A DELA	IDE UNCIL
C_k_i <u>T</u> t_y/projects	DATE	05/2001		ELECTRICA	L LEGEND		
	SCALE	N.T.S.	o convenient			STANDARD NUMBER	SHEET No.
	DRWG No.	C-ES-001-01	© COPYRIGHT This document produced by City of Adelaide shall not copied without written consent.			LT 002	01

CODE NO.	MOUNTING HEIGHT	FOOTING TYPE	OUTREAC		COLUMN TYPE	(B)ANNER	(T)RAFFIC SIGNAL	COLUMN STANDARD	COLUMN DRAWING
	(metres)	(G)round or (F)lange	(metres)	(S)ingle or (D)ouble	1112		(lugs)	REFERENCE	REFERENCE
3.5/G 3.5/G	3.5 3.5	G G			RIGID RIGID			LT120-01 [Option A] LT120-01 [Option B]	C-ES-121-01 [Option A C-ES-121-01 [Option E
3.5/G 3.5/G	3.5 3.5	G G			RIGID RIGID			LT130-01 LT110-01 LT110-02 LT110-03	C-ES-123-01 C-ES-122-01 C-ES-122-02 C-ES-122-03
6.5/G/0.5/S 6.5/G/0.5/S/T	6.5 6.5	G G	0.5 0.5	S S	RIGID RIGID		Т	LT400-01 LT400-02	C-ES-102-01 C-ES-102-02
9.0/G/2.0/S 9.0/G/2.0/S/B 9.0/G/2.0/S/T	9.0 9.0 9.0	000	2.0 2.0 2.0	S S S	RIGID RIGID RIGID	В	т	LT410-01 LT410-01 LT410-02	C-ES-103-01 C-ES-103-01 C-ES-103-02
9.0/F/2.0/S/T 9.0/G/2.0/S/B/T 9.0/F/2.0/S/B/T	9.0 9.0 9.0	F G F	2.0 2.0 2.0 2.0	S S S	IMPACT ABSORBING RIGID IMPACT ABSORBING	B B	T T T	LT410-02 LT410-01 LT410-01	C-ES-103-02 C-ES-103-01 C-ES-103-01
9.0/G/3.0/S 9.0/G/3.0/S/B 9.0/G/3.0/S/T 9.0/F/3.0/S/T	9.0 9.0 9.0 9.0	G G G F	3.0 3.0 3.0 3.0	S S S S	RIGID RIGID RIGID IMPACT ABSORBING	В	T T	LT410-01 LT410-01 LT410-02 LT410-02	C-ES-103-01 C-ES-103-01 C-ES-103-02 C-ES-103-02
9.0/G/3.0/S/B/T 9.0/F/3.0/S/B/T	9.0 9.0	G F	3.0 3.0	S S	RIGID IMPACT ABSORBING	В В	T T	LT410-01 LT410-01	C-ES-103-01 C-ES-103-01
9.0/G/4.5/S 9.0/G/4.5/S/B 9.0/G/4.5/S/T	9.0 9.0 9.0	G G G	4.5 4.5 4.5	S S S	RIGID RIGID RIGID	В	Ţ	LT410-01 LT410-01 LT410-02	C-ES-103-01 C-ES-103-01 C-ES-103-02
9.0/F/4.5/S/T 9.0/G/4.5/S/B/T 9.0/F/4.5/S/B/T	9.0 9.0 9.0	G F	4.5 4.5 4.5	S S S	IMPACT ABSORBING RIGID IMPACT ABSORBING	B B	T T T	LT410-02 LT410-01 LT410-01	C-ES-103-02 C-ES-103-01 C-ES-103-01


NOTE: FOR FOOTING DETAILS REFER STANDARD LT020-01 (Drawing No. C-ES-101-01).


I L	CHECKED CERTIFIED	TL RS			ON STANDARD d Electrical	DELA CITY CO	IDE
C_k_i <u>T</u> t_yyprojects_	DATE	05/2001		COLUMN	OPTIONS		
	SCALE	N.T.S.	o copyrpicut			STANDARD NUMBER	SHEET No.
	DRWG No.	C-ES-100-01	© COPYRIGHT This document produced by City of Adelaide shall not copied without written consent.			LT 010	01


CODE NO.	MOUNTING	FOOTING	OUTREACI	H ARM	COLUMN	BANNER	TRAFFIC	COLUMN	COLUMN
	HEIGHT (metres)	TYPE Ground or Flange	(metres)	Single or Double	TYPE		SIGNAL (lugs)	STANDARD REFERENCE	DRAWING REFERENCE
10.5/G/2.0/S 10.5/G/2.0/S/B 10.5/G/2.0/S/T 10.5/F/2.0/S/T 10.5/F/2.0/S/B/T 10.5/F/2.0/S/B/T	10.5 10.5 10.5 10.5 10.5 10.5	000F0F	2.0 2.0 2.0 2.0 2.0 2.0	S S S S S S	RIGID RIGID RIGID IMPACT ABSORBING RIGID IMPACT ABSORBING	B B B	T T T T	LT410-01 LT410-01 LT410-02 LT410-02 LT410-01 LT410-01	C-ES-103-01 C-ES-103-01 C-ES-103-02 C-ES-103-02 C-ES-103-01 C-ES-103-01
10.5/G/3.0/S 10.5/G/3.0/S/B 10.5/G/3.0/S/T 10.5/F/3.0/S/T 10.5/G/3.0/S/B/T 10.5/F/3.0/S/B/T	10.5 10.5 10.5 10.5 10.5 10.5	G G G F G F	3.0 3.0 3.0 3.0 3.0 3.0	99999	RIGID RIGID RIGID IMPACT ABSORBING RIGID IMPACT ABSORBING	B B B	T T T T	LT410-01 LT410-01 LT410-02 LT410-02 LT410-01 LT410-01	C-ES-103-01 C-ES-103-01 C-ES-103-02 C-ES-103-02 C-ES-103-01 C-ES-103-01
10.5/G/4.5/S 10.5/G/4.5/S/B 10.5/G/4.5/S/T 10.5/F/4.5/S/T 10.5/G/4.5/S/B/T 10.5/F/4.5/S/B/T	10.5 10.5 10.5 10.5 10.5 10.5	0	4.5 4.5 4.5 4.5 4.5 4.5	S S S S S S	RIGID RIGID RIGID IMPACT ABSORBING RIGID IMPACT ABSORBING	B B B	T T T T	LT410-01 LT410-01 LT410-02 LT410-02 LT410-01 LT410-01	C-ES-103-01 C-ES-103-01 C-ES-103-02 C-ES-103-02 C-ES-103-01 C-ES-103-01
10.5/F/2.0/D 10.5/F/3.0/D 10.5/F/4.5/D	10.5 10.5 10.5	F F F	2.0 3.0 4.5	D D D	IMPACT ABSORBING IMPACT ABSORBING IMPACT ABSORBING			LT421-01 LT421-01 LT421-01	C-ES-105-01 C-ES-105-01 C-ES-105-01


NOTE: FOR FOOTING DETAILS REFER STANDARD LT020-01 (Drawing No. C-ES-101-01).


DESIGNED TL CHECKED TL DRAWN JR/JB/TL CERTIFIED RS DATE 05/2001		IL			ON STANDARD d Electrical	ADELA CITY CO	IDE
C k i v v projects	DATE	05/2001		COLUMN	OPTIONS		
	SCALE	N.T.S.	© OODVINGUT			STANDARD NUMBER	SHEET No.
	DRWG No.	C-ES-100-02	© COPYRIGHT This document produced by City of Adelaide shall not copied without written consent.			LT 010	02

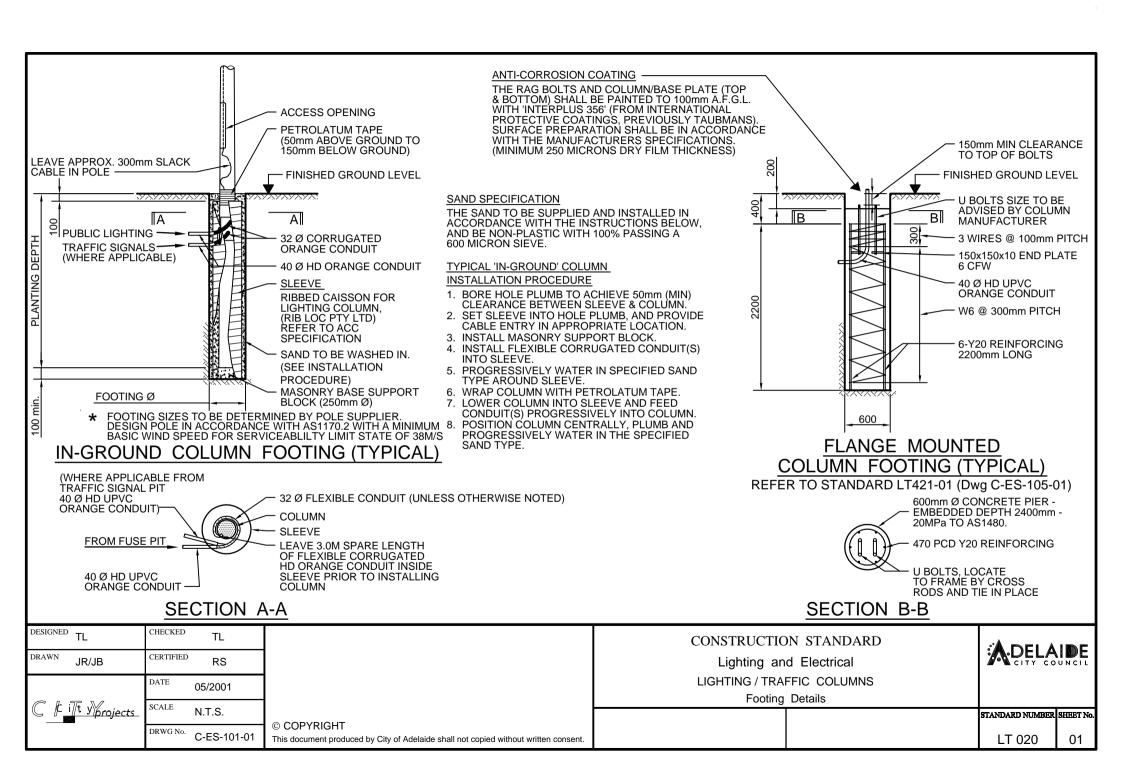

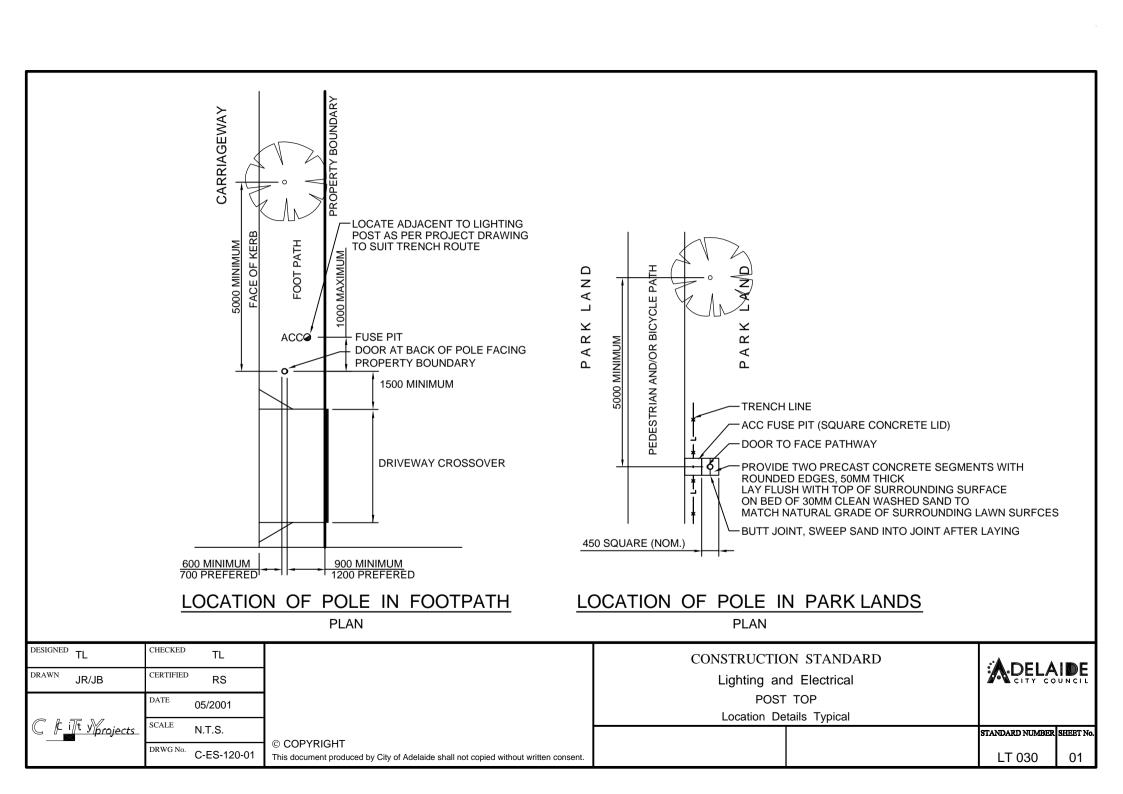

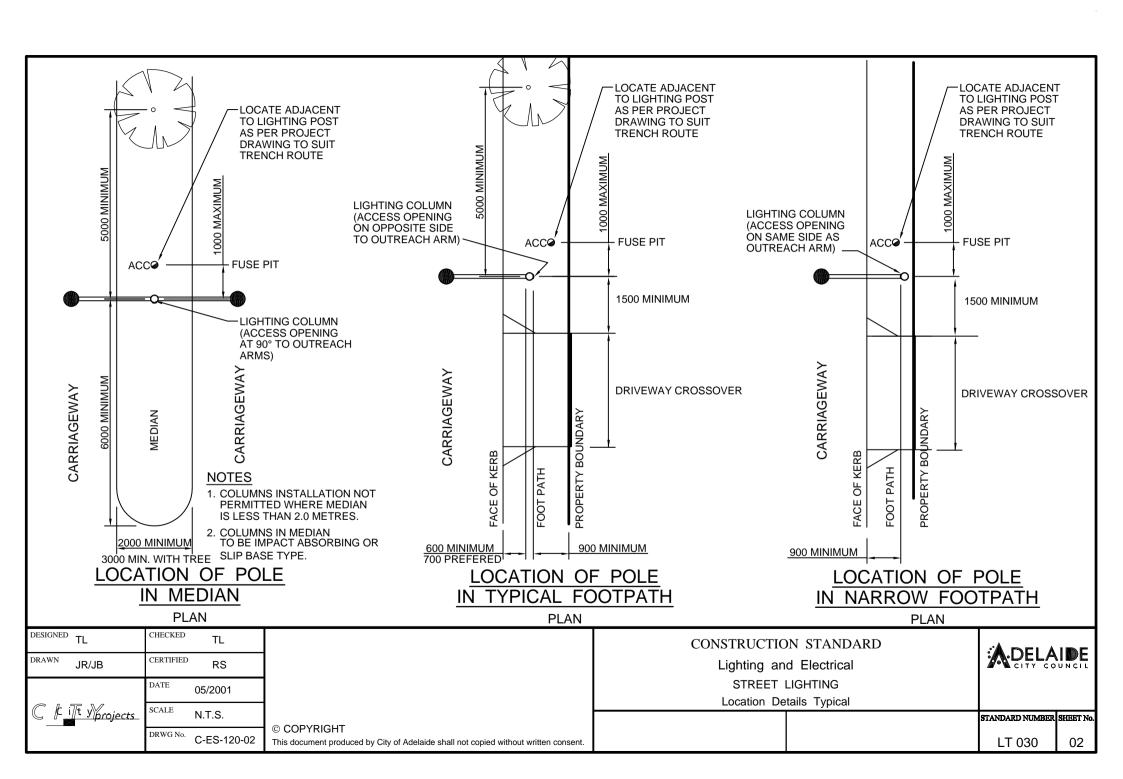

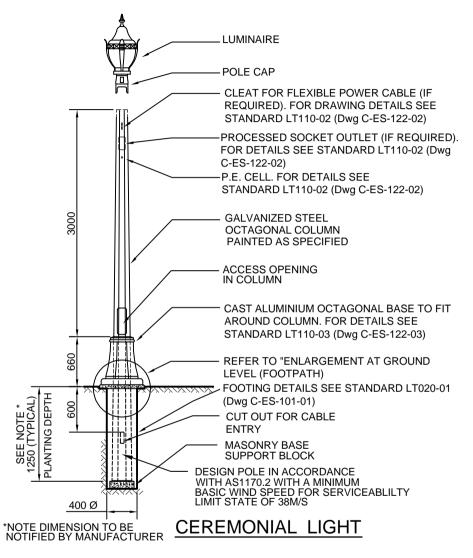

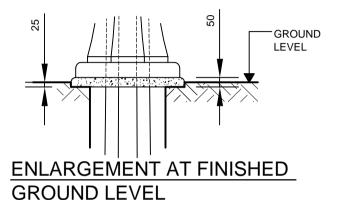

NOTE

- COLUMN TO CONFORM TO RELEVANT AUSTRALIAN STANDARDS AND ATTACHED ACC SPECIFICATION.
- 2. COLUMN SHALL BE HOT DIPPED GALVANIZED AND WET PAINTED IN ACCORDANCE WITH ATTACHED ACC SPECIFICATION.
- 3. PAINT FINISH DULUX OYSTER REFER PAINTING SPECIFICATION FOR APPLICATION
- 4. POLE IDENTIFICATION LABEL REQUIREMENTS


 CORPORATION OF THE CITY OF ADELAIDE


 MANUFACTURER'S NAME


 CONTRACT NUMBER


 MONTH/YEAR OF MANUFACTURE


DESIGNED TL	CHECKED TL		CONSTRUCTIO	N STANDARD	.:A DELA	ובר
DRAWN JR/JB	CERTIFIED RS		Lighting an	d Electrical	DELA	UNCIL
1	DATE 05/2001		3.5M PC			
C F:5E .V/	SCALE N.T.O.	1	Ceremonia	al Column		
C i i y projects	SCALE N.T.S.				STANDARD NUMBER	SHEET No.
	DRWG No. C-ES-122-01	© COPYRIGHT This document produced by City of Adelaide shall not copied without written consent.			LT 110	01

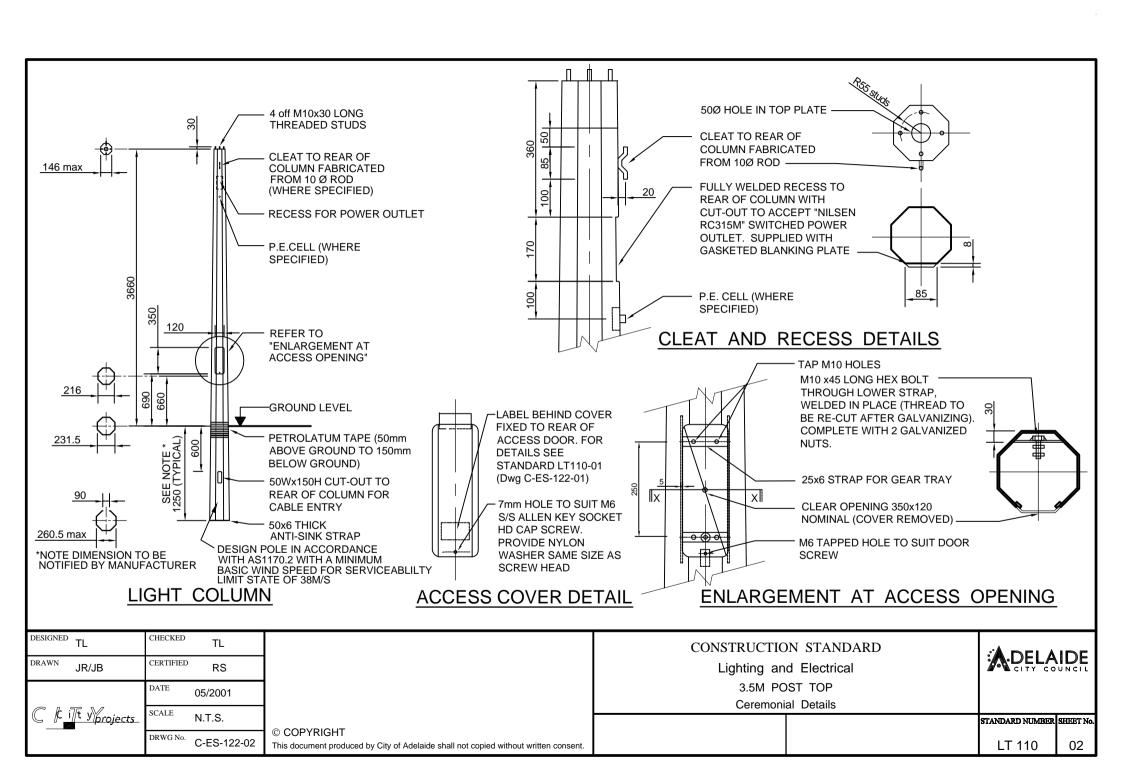

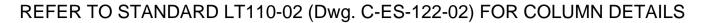

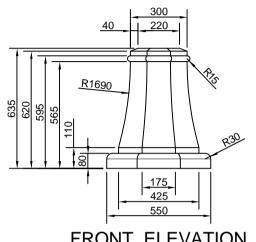

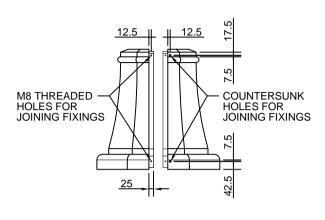


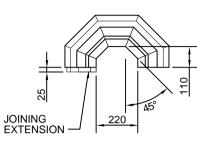


FRONT ELEVATION

SIDE ELEVATION (separated)

HALF TOP VIEW

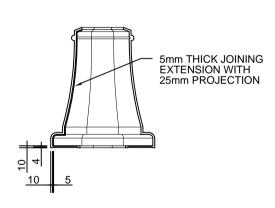



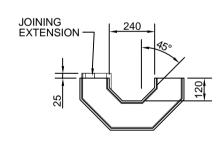

INTERNAL ELEVATION

INTERNAL ELEVATION (sides separated)

HALF BOTTOM VIEW


DESIGNED TL	CHECKED	TL	
DRAWN JR/JB	CERTIFIED	RS	
	DATE	05/2001	
C k int y/proj	ects_SCALE	N.T.S.	@ CODVDICUT
	DRWG No.	C-ES-122-03	© COPYRIGHT This document produced by City of Adelaide shall not copied without written consent.


CONSTRUCTION STANDARD Lighting and Electrical 3.5M POST TOP Ceremonial Base


STANDARD NUMBER SHEET No.

LT 110

03

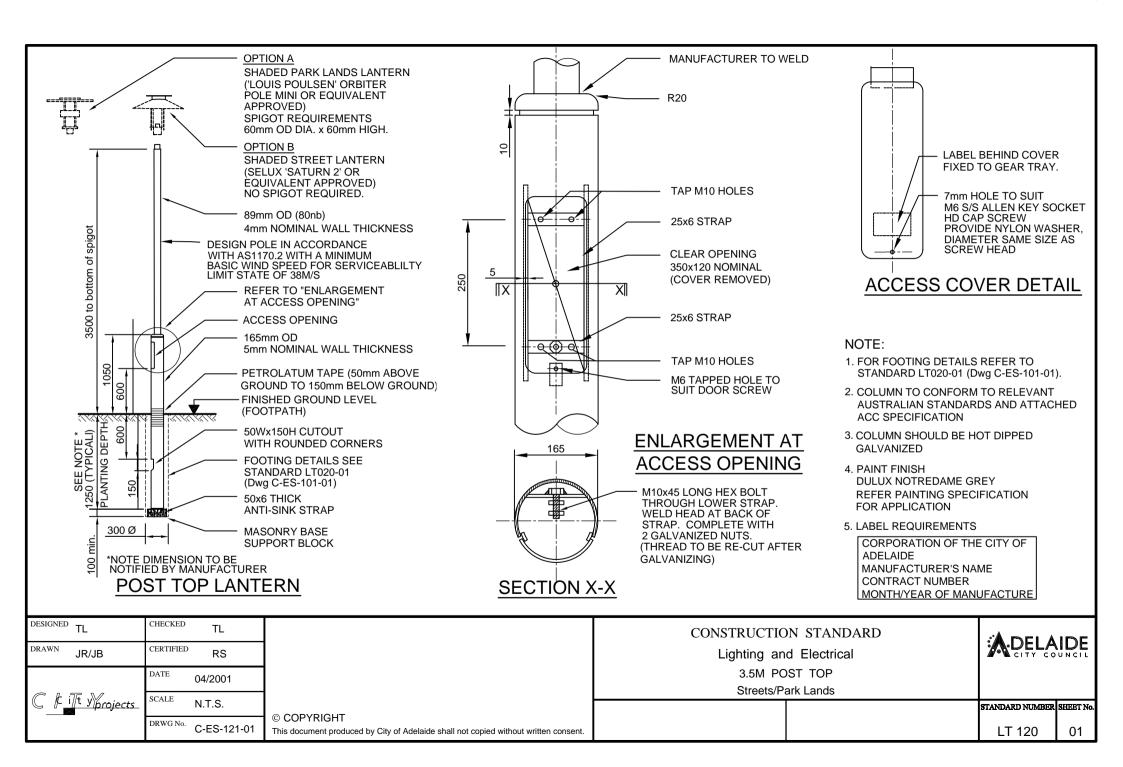

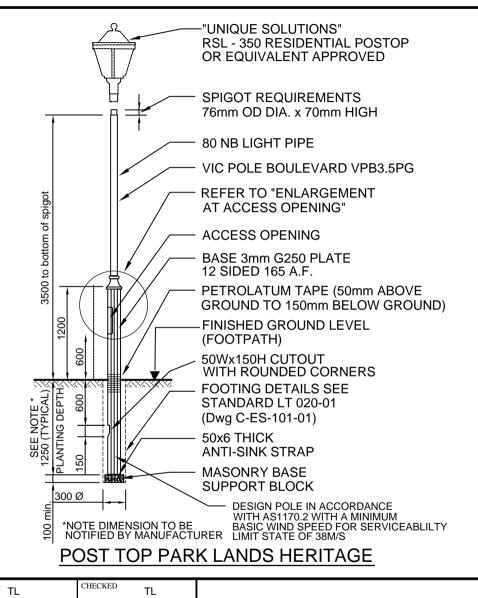

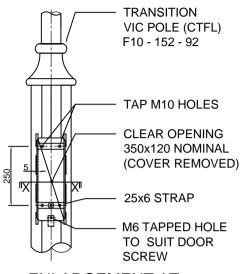

- LABEL BEHIND COVER FIXED TO REAR OF ACCESS DOOR

-7mm HOLE TO SUIT M6 S/S ALLEN KEY SOCKET HD CAP SCREW PROVIDE NYLON WASHER, DIAMETER SAME SIZE AS SCREW HEAD

ENLARGEMENT AT ACCESS OPENING

ACCESS COVER DETAIL



M10x45 LONG HEX BOLT THROUGH LOWER STRAP. WELD HEAD AT BACK OF STRAP. (THREAD TO BE RE-CUT AFTER GALVANIZING) COMPLETE WITH 2 GALVANIZED NUTS.

SECTION X-X

NOTE:

- 1. FOR FOOTING DETAILS REFER TO STANDARD LT020-01 (Dwg C-ES-101-01)
- 2. PAINT FINISH
 DULUX BLACK
 REFER PAINT SPECIFICATION
 FOR APPLICATION
- 3. LABEL REQUIREMENTS

 CORPORATION OF THE CITY OF


 ADELAIDE


 MANUFACTURER'S NAME


 CONTRACT NUMBER

 MONTH/YEAR OF MANUFACTURE

DESIGNED TL	CHECKED TL		CONSTRUCTIO	ON STANDARD	A DELA	UDE
DRAWN JB	CERTIFIED RS		Lighting an	d Electrical	DEL A	NUNCIL
	DATE 04-2001		3.5M PC			
	SCALE N.T.O.		Heri	tage		
C_k i t y projects	SCALE N.T.S.	a convenious			STANDARD NUMBER	SHEET No
	DRWG No. C-ES-123-01	© COPYRIGHT This document produced by City of Adelaide shall not copied without written consent.			LT 130	01

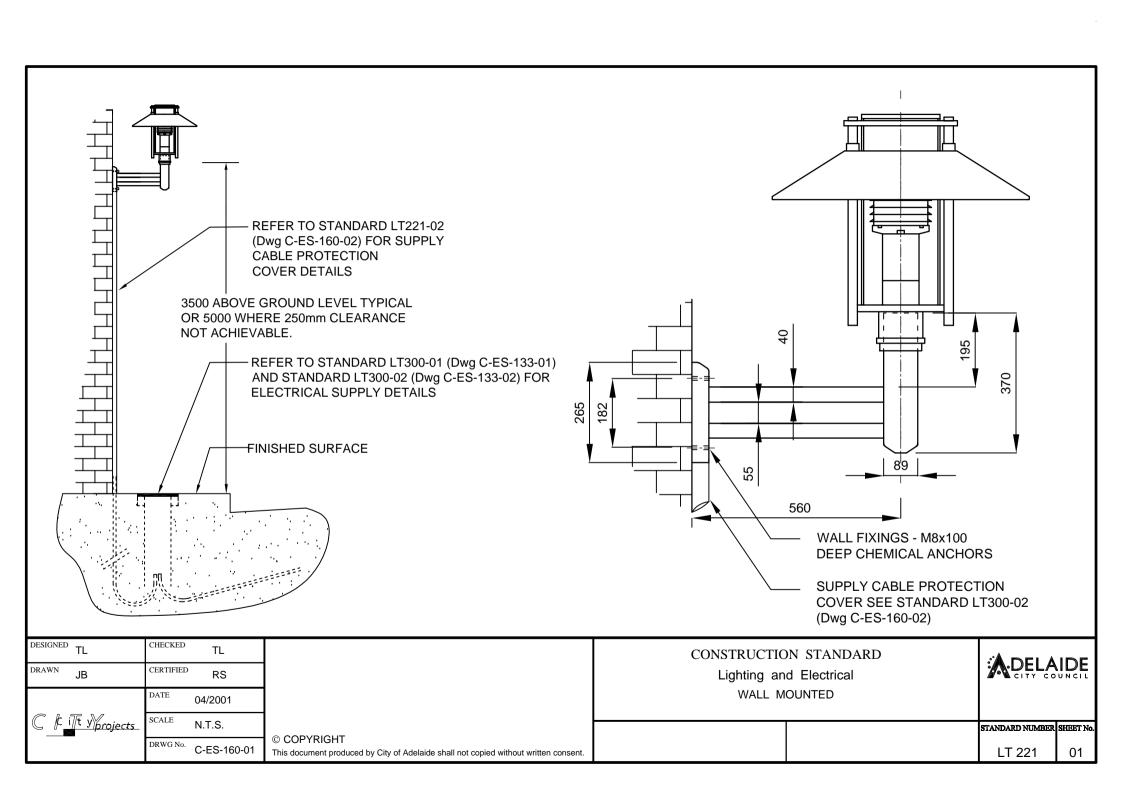


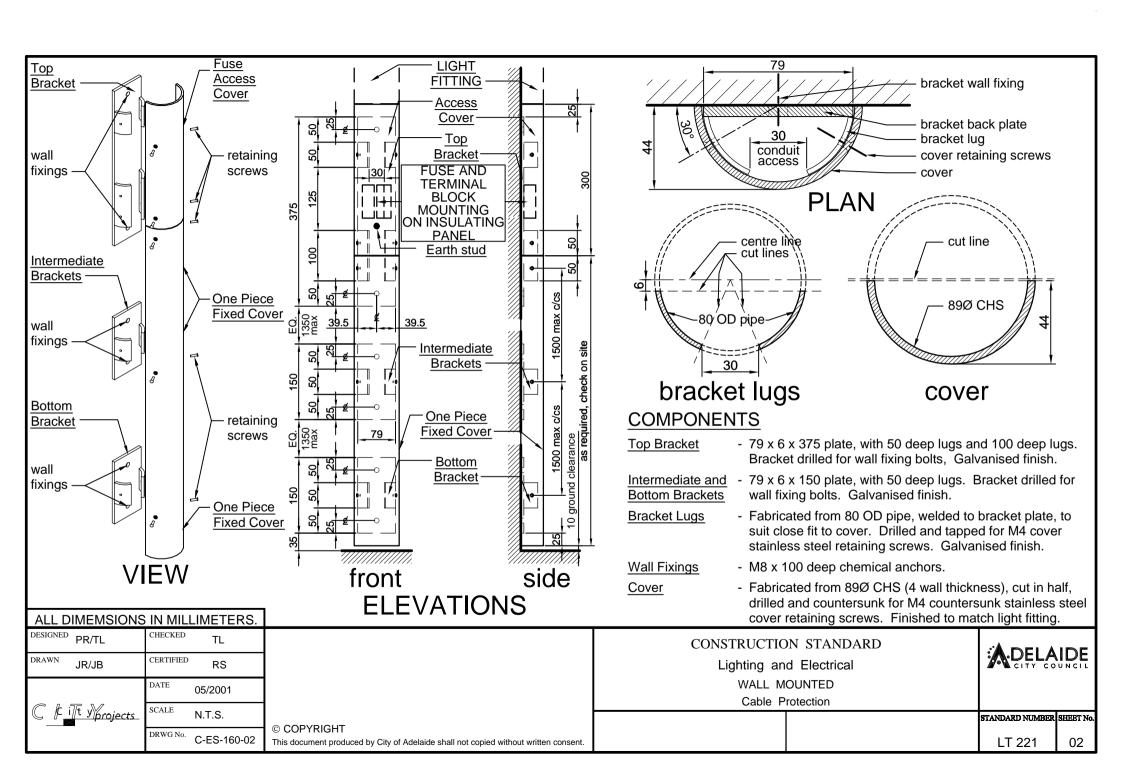

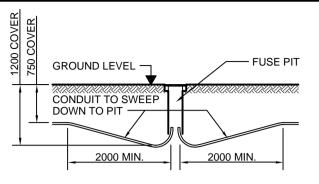

ΓΕΜ NO.	STOCK NO.	DESCRIPTION	SUPPLIER
1	RA 5473	ETSA	
2		UNDERGROUND ELECTRICAL ENCLOSURE	
3		UNDERGROUND ELECTRICAL ENCLOSURE COVER	
4	RA 5487	225 Ø NOM. FIBRE CEMENT SLEEVE	ETSA
(5)	RA 5476	METAL LID FOR 300 Ø SLEEVE	ETSA

CONDUIT ROUTE IN FOOTPATH

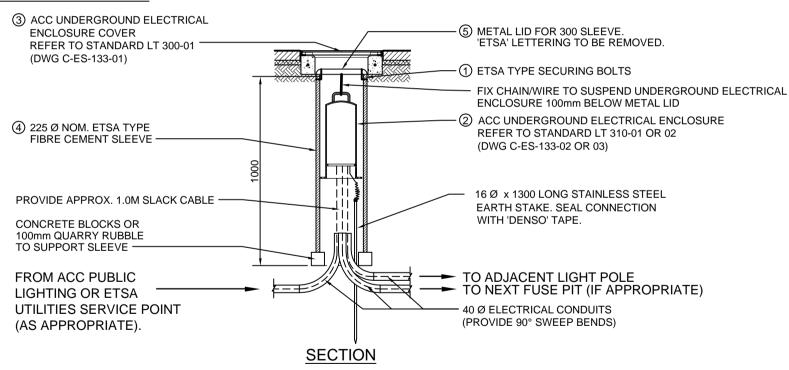

DESIGNED TL	CHECKED	TL		Γ
DRAWN TL/B	B/JB CERTIFIED	RS		l
	DATE	01/2002		l
	rojects SCALE	N.T.S.	- CODYDIGUE	H
	DRWG No.	C-ES-133-00	© COPYRIGHT This document produced by City of Adelaide shall not copied without written consent.	

CONSTRUCTION STANDARD

Lighting and Electrical

UNDERGROUND ELECTRICAL ENCLOSURE


Pit


DELAIDE CITY COUNCIL


STANDARD NUMBER SHEET No.


LT 300


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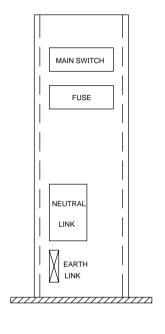


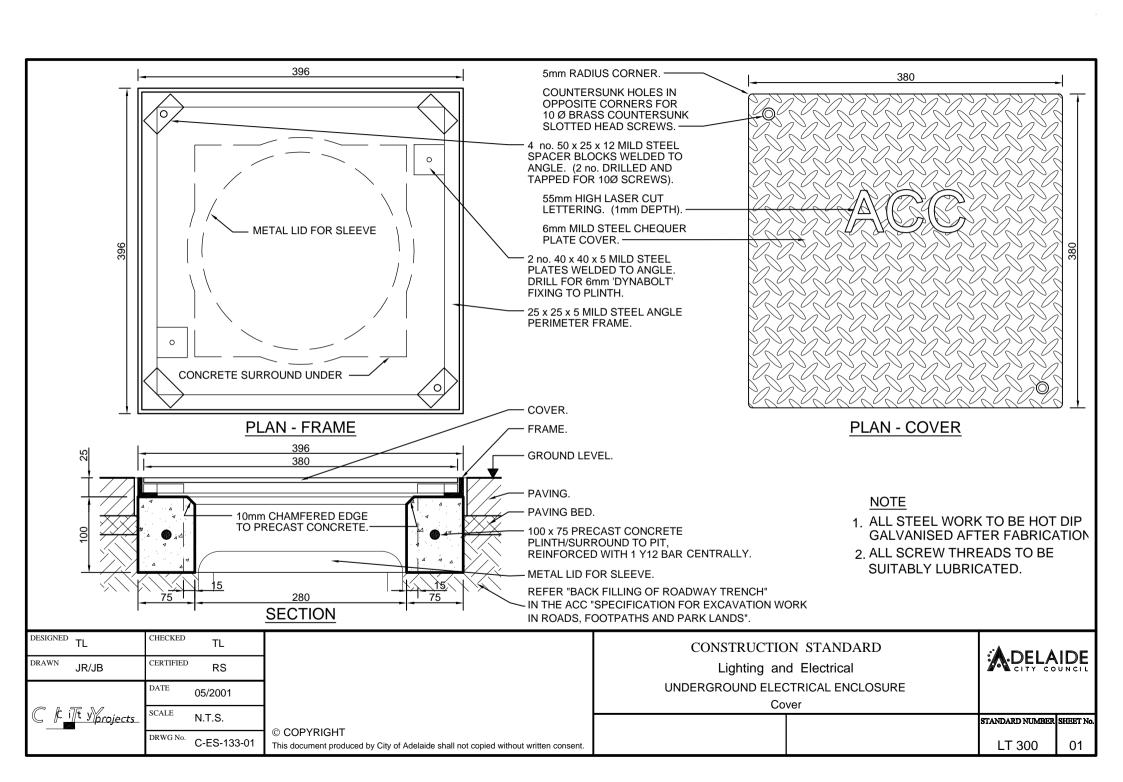

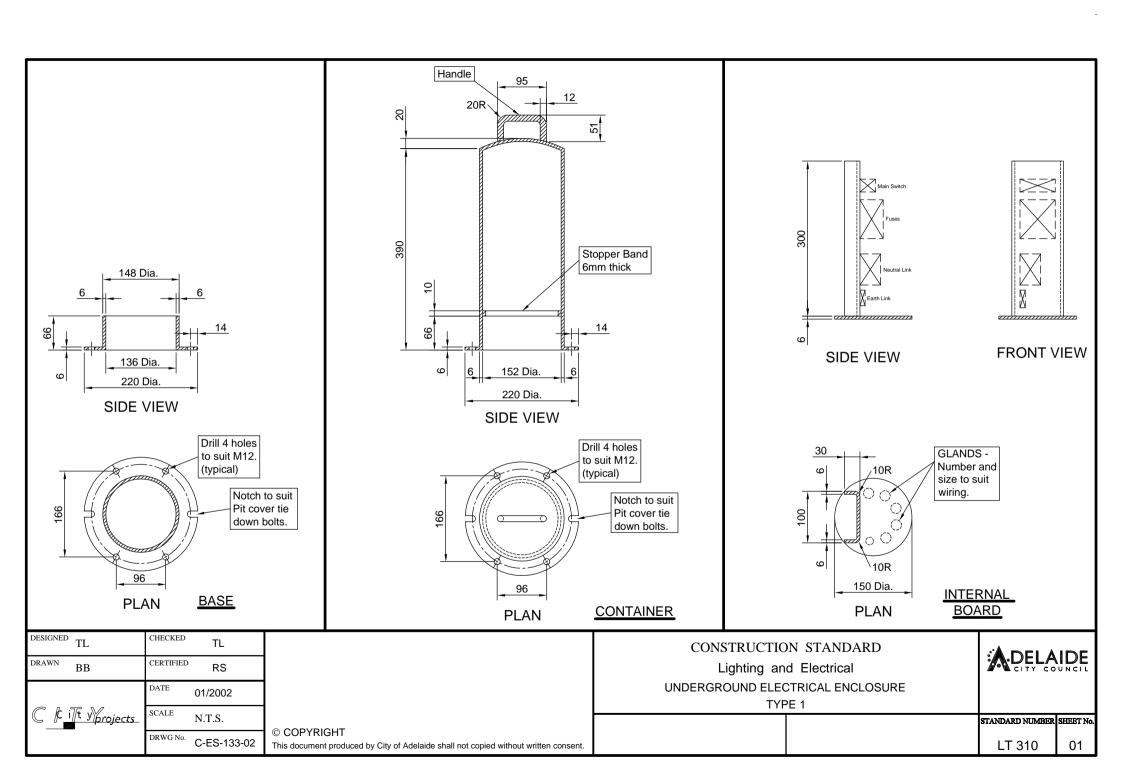

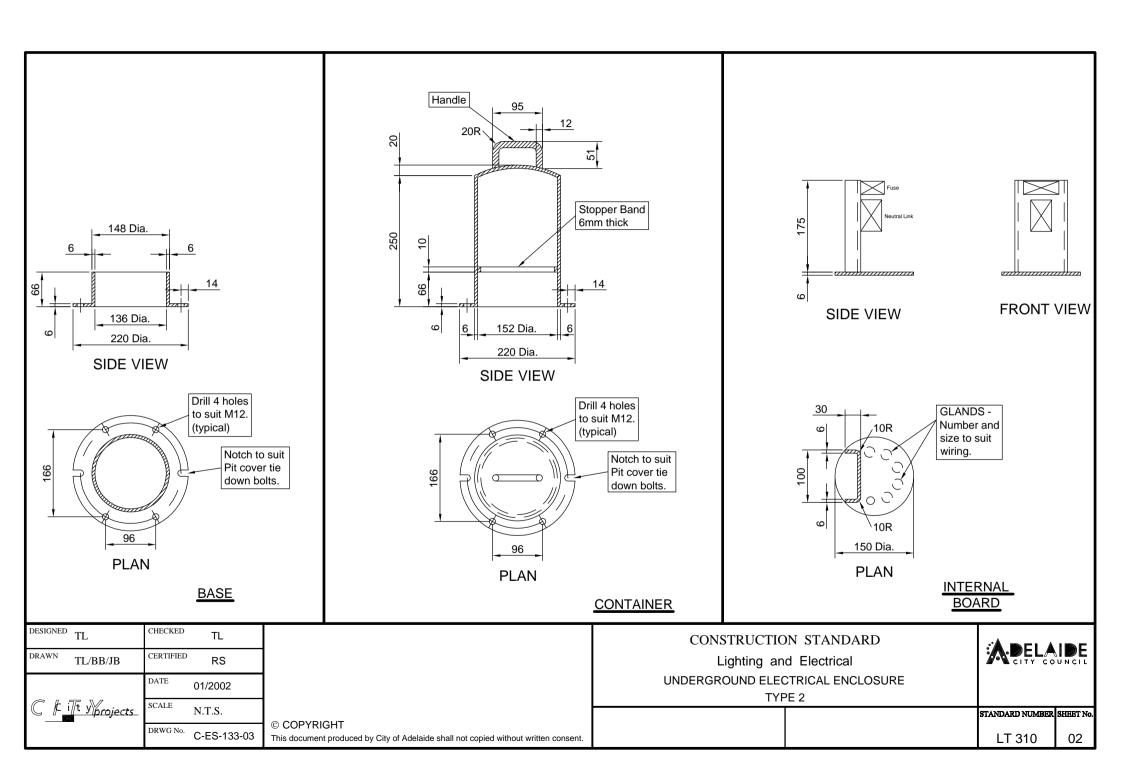

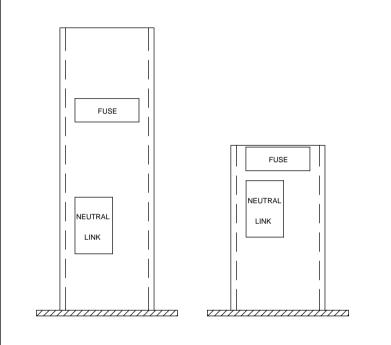

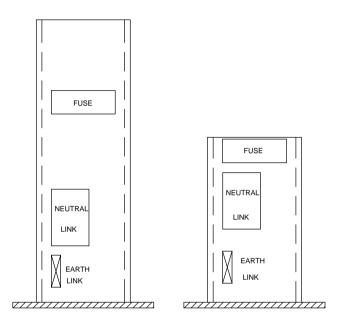


ACC ADAPTABLE FUSE ENCLOSURE


SEE DRAWING LT700 SHEET 01


ACC FUSE PIT
SEE DRAWING LT700 SHEET 02


ACC SWITCHBOARD
SEE DRAWING LT700 SHEET 02


DESIGNED TL	CHECKED TL		CONSTRUCTION STANDARD		A DELA	וחר
DRAWN JB/BB	CERTIFIED RS		Lighting and Electrical		ADELA	UNCIL
C <u>F</u> i Jt yyprojects	DATE 01/2002		UNDERGROUND ELECTRICAL ENCLOSURE INTERNAL BOARD OPTIONS			
	SCALE N.T.S.		INTERNAL BOA		STANDARD NUMBER	SHEET No.
	DRWG No. C-ES-133-04	© COPYRIGHT This document produced by City of Adelaide shall not copied without written consent.			LT 310	03

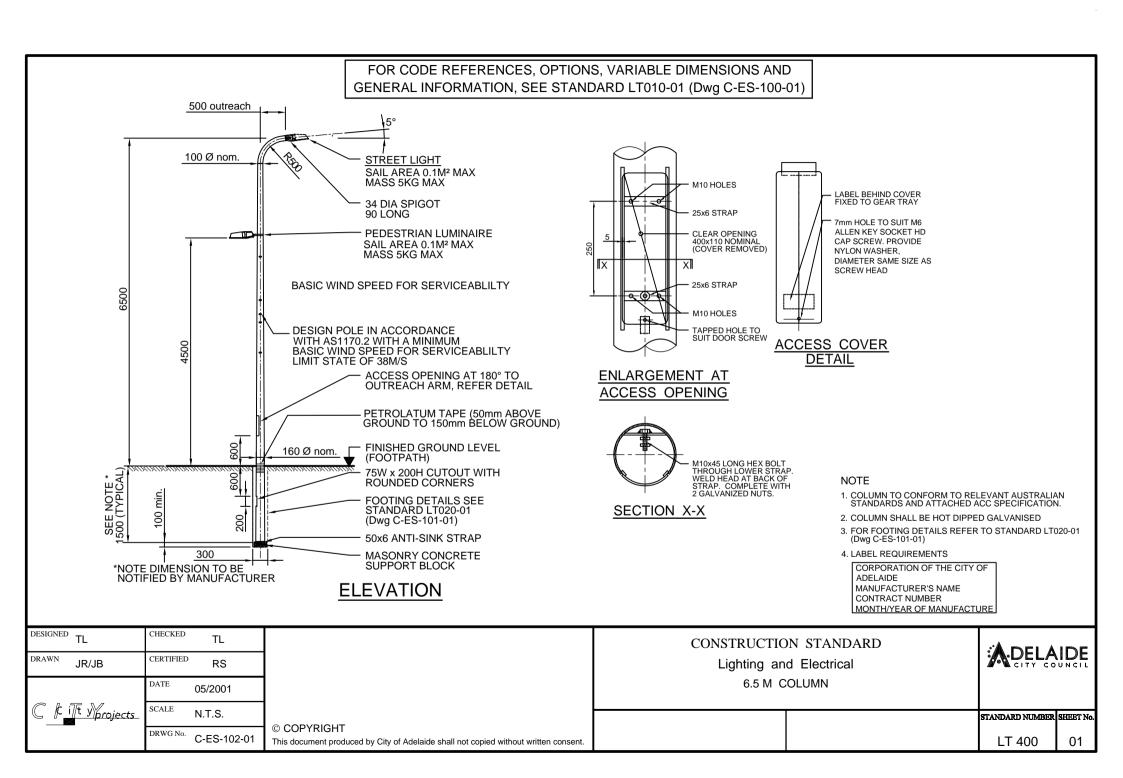


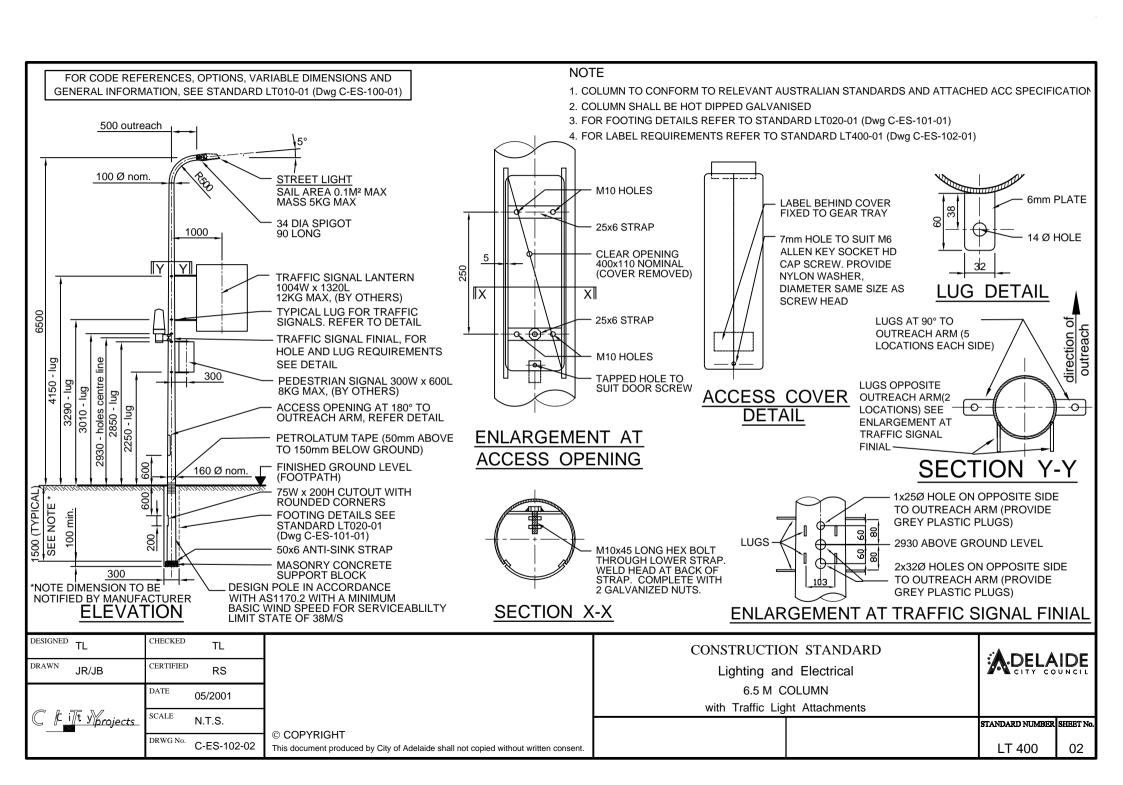


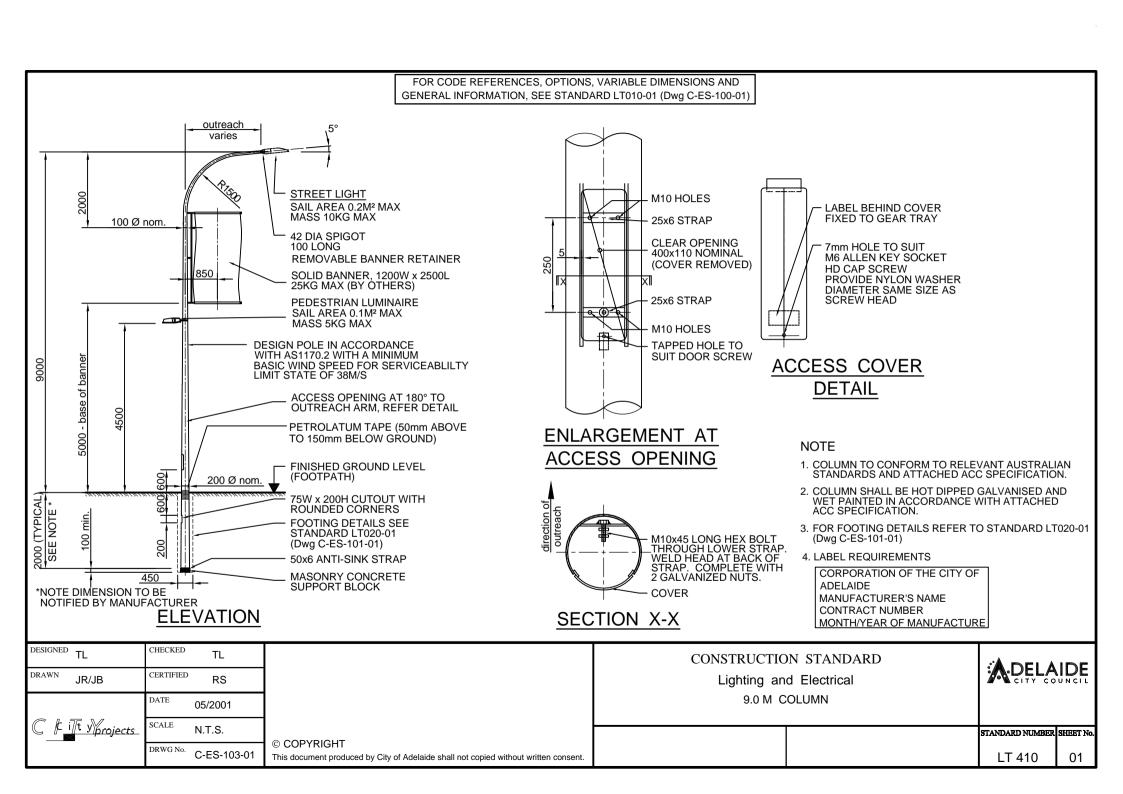


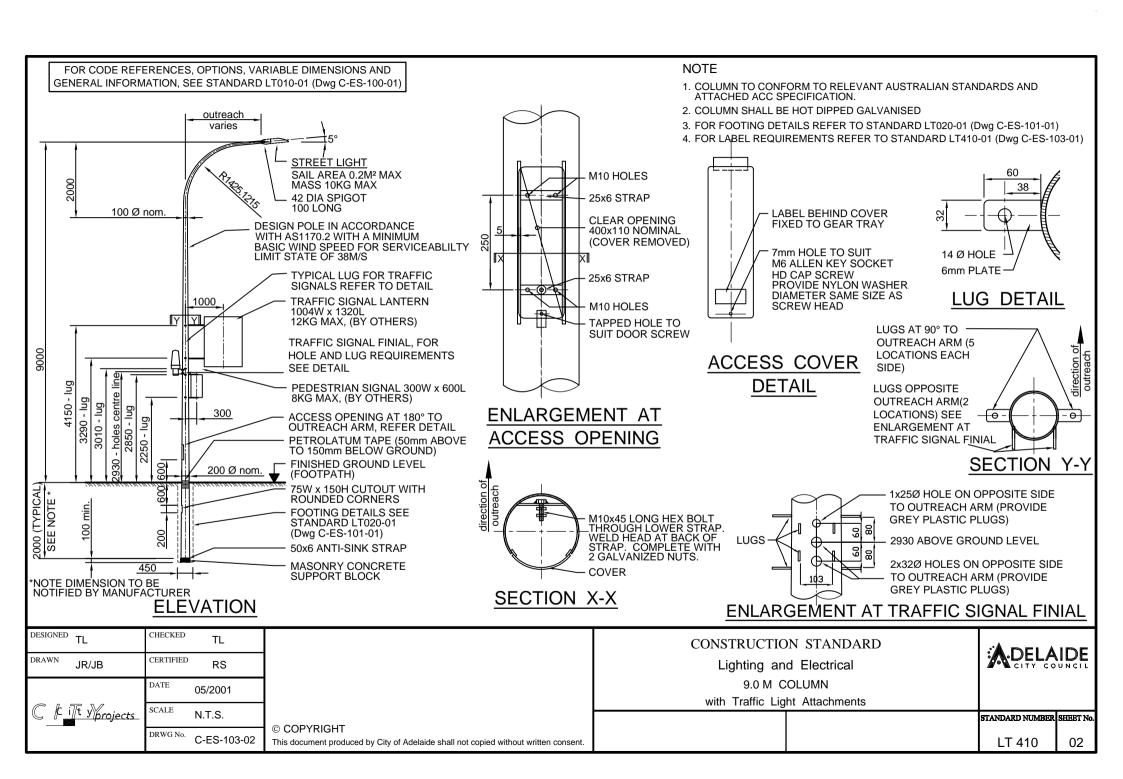


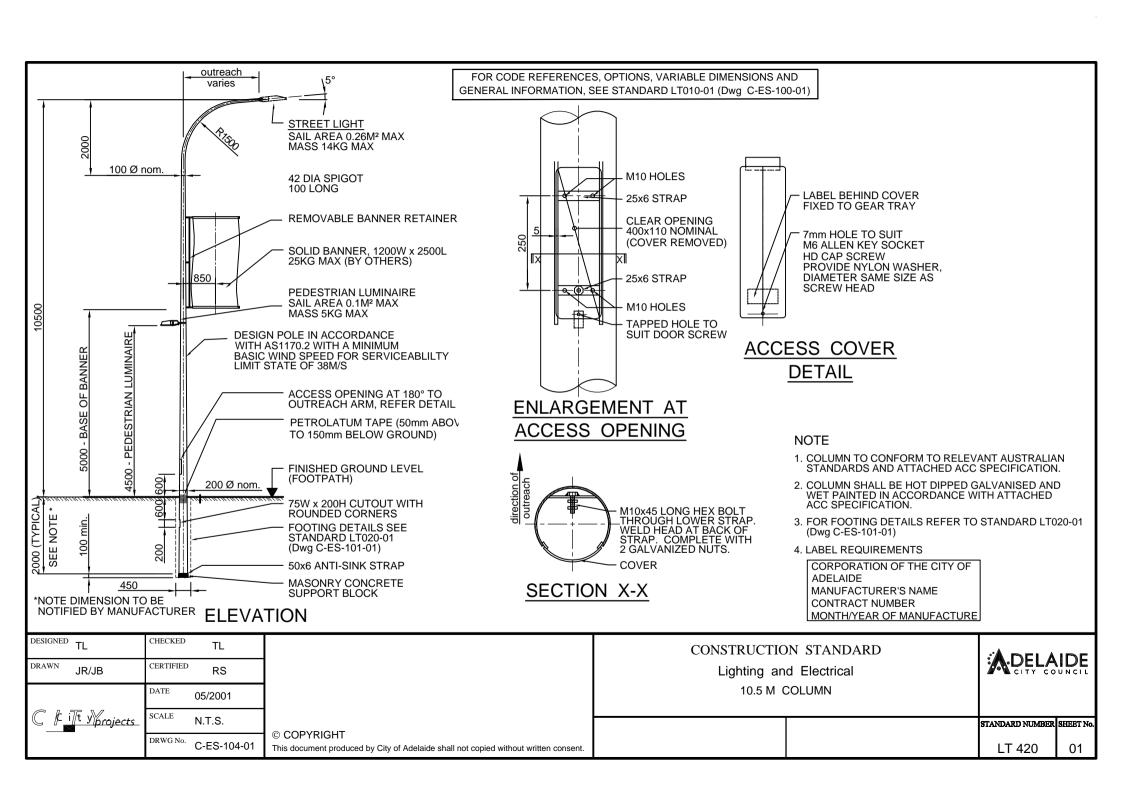


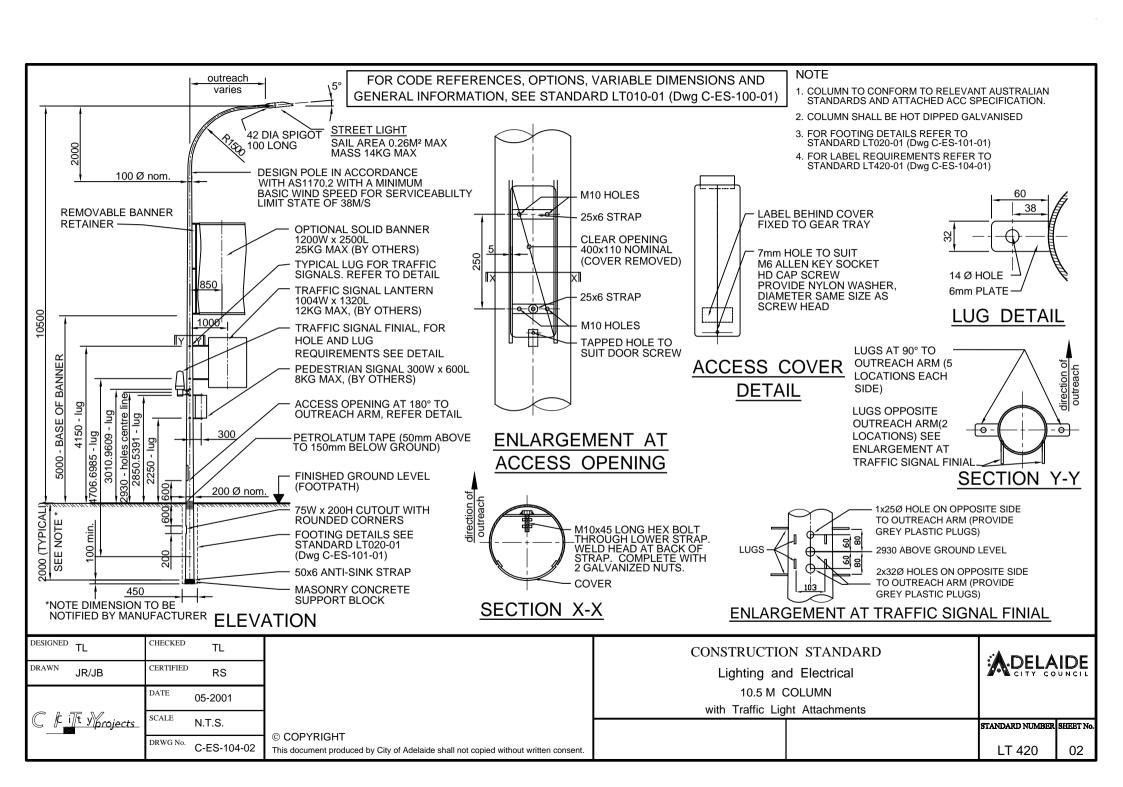

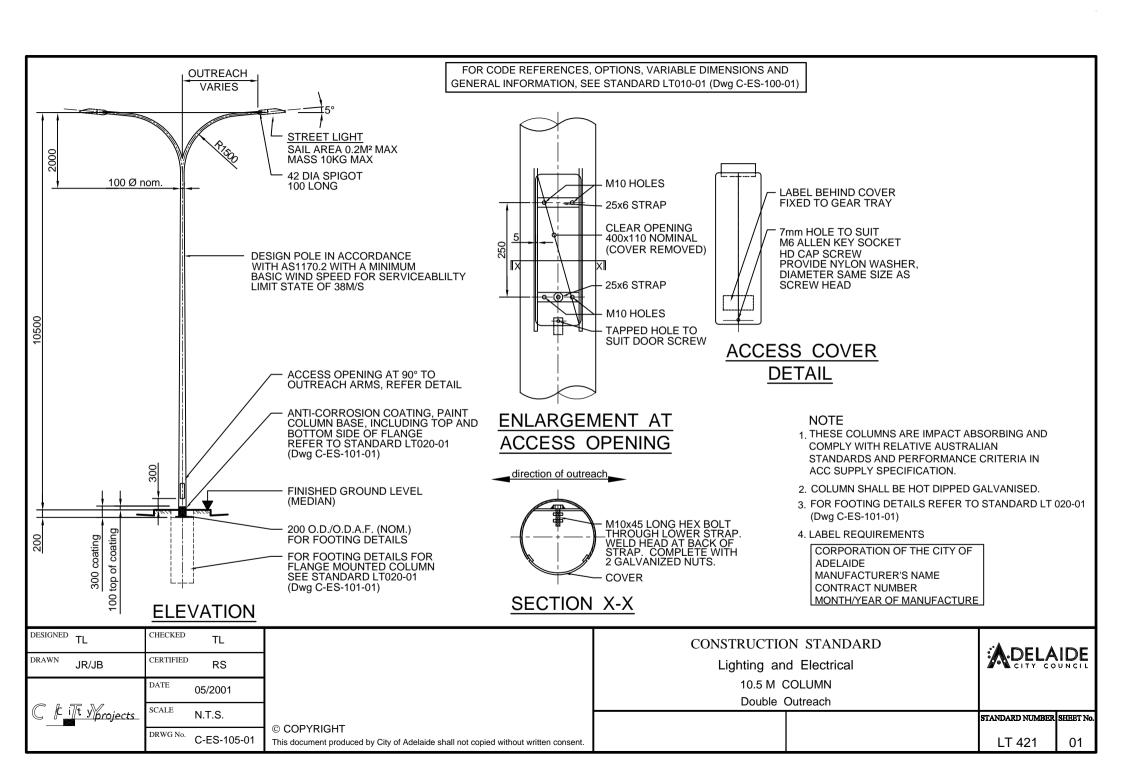

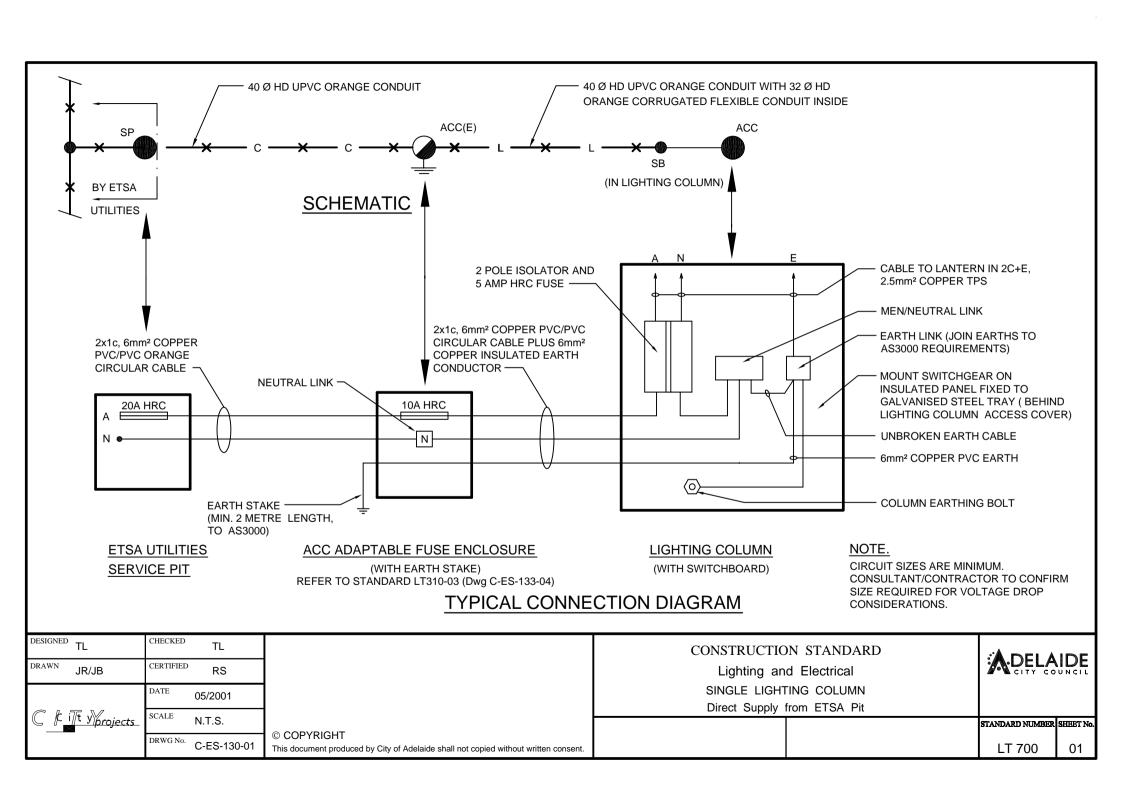


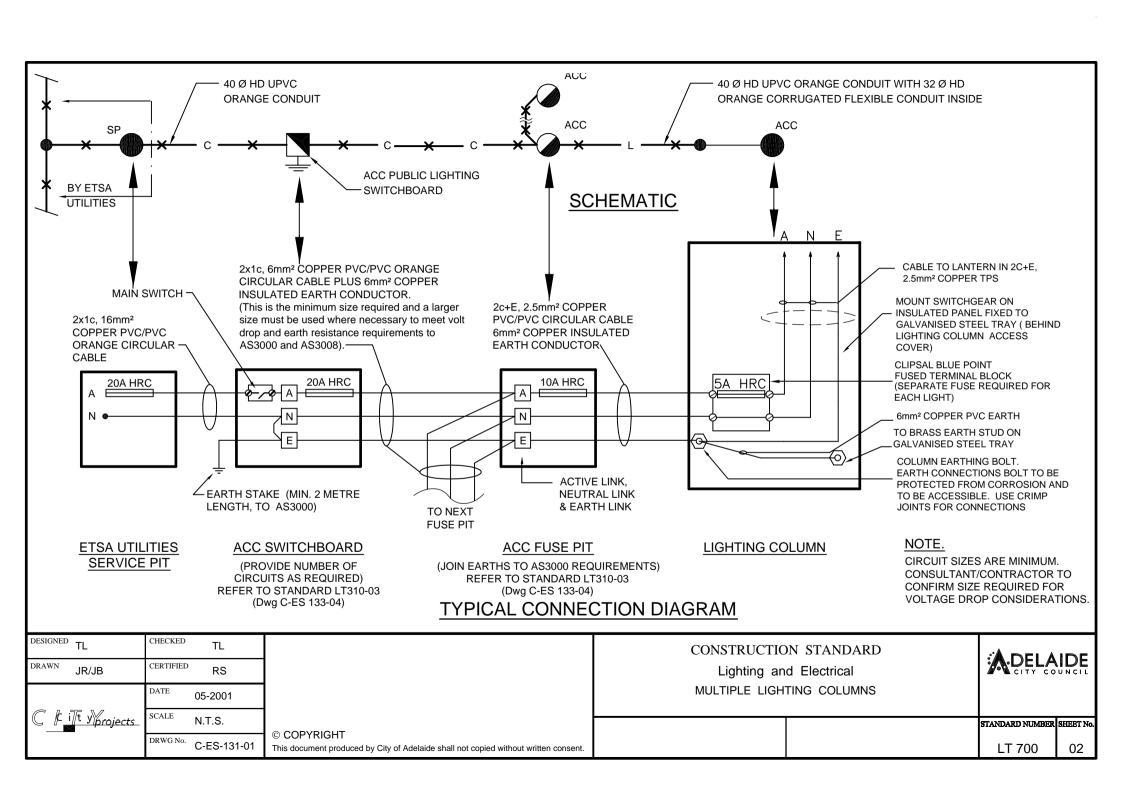

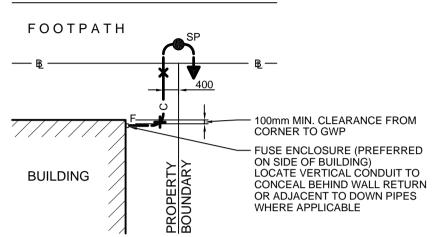

NOTE

CONTRACTOR TO LIAISE WITH TELSTRA FOR UTILISING CONSUMER MAINS SERVICE TRENCH (WHERE APPLICABLE)

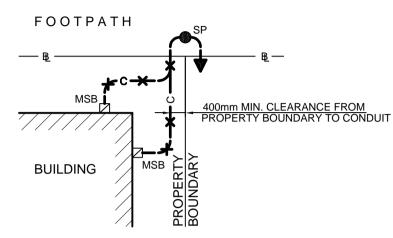

OPTION 2
TO EXISTING METER SWITCHBOARD

OPTION 1 TO NEW ETSA UTILITIES FUSE ENCLOSURE

SCHEDULE


NEW CONSUMER MAINS SERVICE


<u>NOTES</u>

- CONTRACTOR TO LIAISE WITH TELECOMMUNICATIONS AUTHORITY FOR SHARING OF CONSUMER MAINS SERVICE TRENCH (WHERE APPLICABLE).
- METHOD AND TYPE OF FIXINGS USED FOR GWP SHALL BE TO APPROVAL OF SUPERINTENDENT.
- 3. THE INSTALLED PVC BEND AND COUPLING ADAPTOR SHALL BE INSPECTED BY SUPERINTENDENT PRIOR TO BACK FILLING.
- 4. THE PROPOSED GWP AND FUSE ENCLOSURE SHALL BE PAINTED WITH PRIMER AND TWO COATS OF EXTERIOR PAINT. COLOUR TO MATCH THE WALL OR STRUCTURE THAT EQUIPMENT IS MOUNTED TO.
- 5. FOR ELEVATIONS, REFER TO STANDARD LT800-02 (Dwg C-ES-150-02).

R E).	SERVICE TYPE	No. OF PHASES	SERVICE CAPACITY	CABLE SIZE & TYPE Cu,PVC/PVC	U/G CONDUIT HD UPVC NOM.SIZE	ABOVEGROUND GWP (MEDIUM DUTY) NOM. BORE	DIMENSIONS OF FUSE ENCLOSURE (W x H x D)
	Α	1	70AMP	16mm²	32Ø	25Ø	380 x 200 x 180
	В	2	60AMP	16mm²	40Ø	32Ø	380 x 200 x 180
	С	3	60AMP	16mm²	40Ø	32Ø	380 x 300 x 180
	D	3	100AMP	25mm²	50Ø	40Ø	380 x 300 x 180
	E	3	100AMP	35mm²	50Ø	40Ø	380 x 300 x 180
	F	3	200AMP	95mm²	65Ø	65Ø	800 x 370 x 250

DESIGNED TL	CHECKED TL		CONSTRUCTION STA	NDARD	A DELAIDE	
DRAWN JR/JB	CERTIFIED RS		Lighting and Electrical		DELA	UNCIL
	DATE 05/2001		UNDERGROUNDING OF PRIVATE PROPERTIES Plan and Schedule			
C k <u>iJt y</u> projects	SCALE N.T.S.		Flatt and Schedule		ANDARD NUMBER S	SHEET NO
	DRWG No. C-ES-150-01	© COPYRIGHT This document produced by City of Adelaide shall not copied without written consent.			LT 800	01

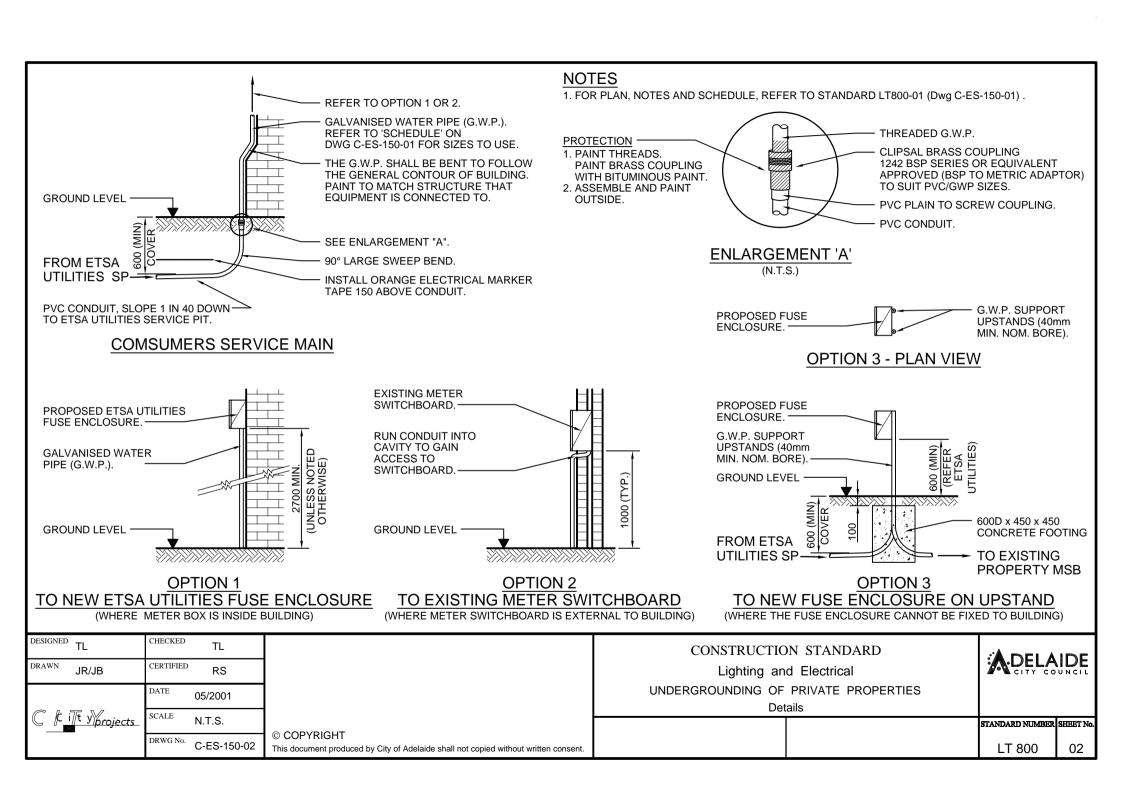


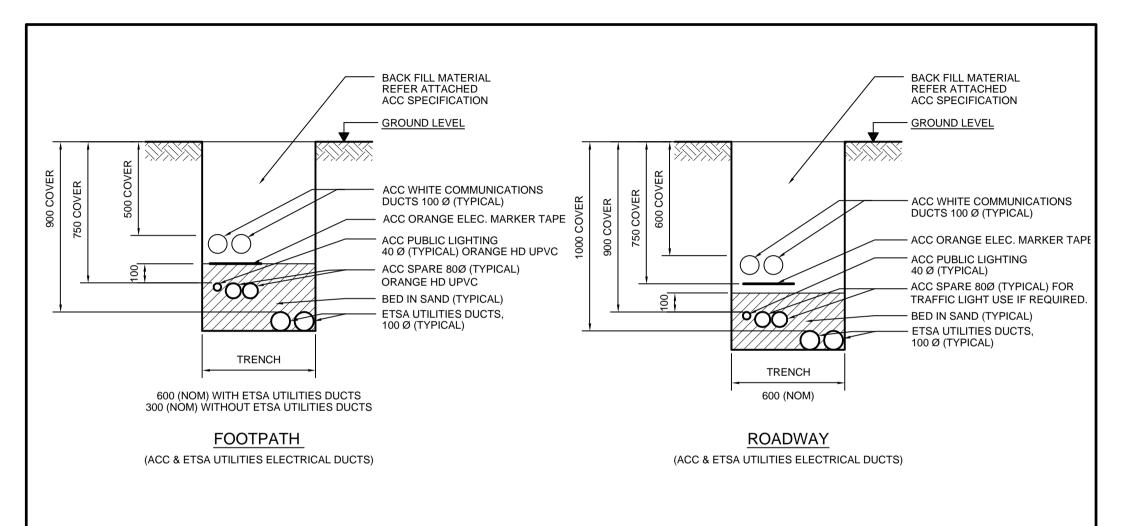


NOTE

1. CO-ORDINATE DUCTING REQUIREMENTS WITH ALL SERVICE AUTHORITIES

DESIGNED TL	CHECKED TL		CONSTRUCTIO	ON STANDARD		IDE
DRAWN JR/JB	CERTIFIED RS		Lighting and Electrical		M.D.F.L.A.	INCIL
	DATE 05/2001		TREN Stre			
	SCALE N.T.S.		Sile		STANDARD NUMBER	SHEET No.
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PARK LANDS - GENERAL

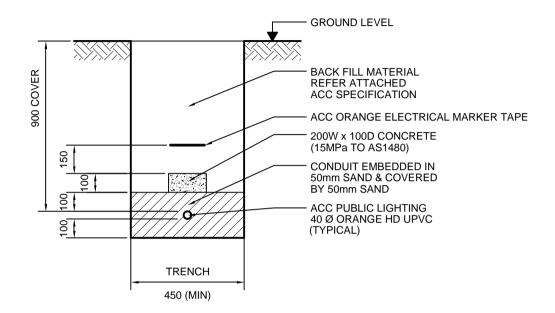NOTE

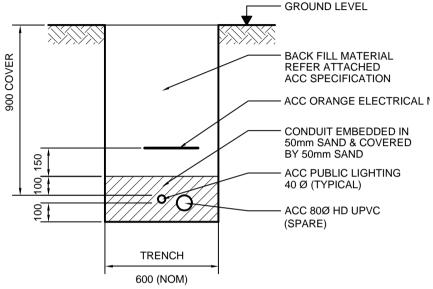
- 1 CO-ORDINATE DUCTING REQUIREMENTS WITH ALL SERVICE AUTHORITIES.
- 2 PERMANENT CABLE MARKERS REQUIRED AT MAXIMUM SPACING OF 30 METRES FOR LONG STRAIGHT ROUTES AND AT ANY CHANGE OF DIRECTION.
- 3 EVENT AREAS SHALL BE AS PARKLANDS GENERAL, BUT WITH 1500mm COVER.

PARK LANDS - PATHWAY LIGHTING

(FOR PUBLIC LIGHTING UNDER OR ADJACENT TO PATHWAYS, WHERE CABLE ROUTE IS CLEARLY DEFINED. CONTACT ACC PROJECT MANAGER TO DETERMINE ACCEPTABLE LOCATIONS)

IT IS NOT TO BE USED IN EVENT AREAS.

DESIGNED TL	CHECKED TL		CONSTRUCTION STANDARD		A DELA	
DRAWN JR/JB	CERTIFIED RS		Lighting and Electrical		DELA	NIDE
DATE 05/2001			TRENCHES			
@ L57 N/			Park	Lands		
C lt iJt yyprojects	SCALE N.T.S.				STANDARD NUMBER	SHEET No.
	DRWG No. C-ES-141-01	© COPYRIGHT This document produced by City of Adelaide shall not copied without written consent.			LT 900	02

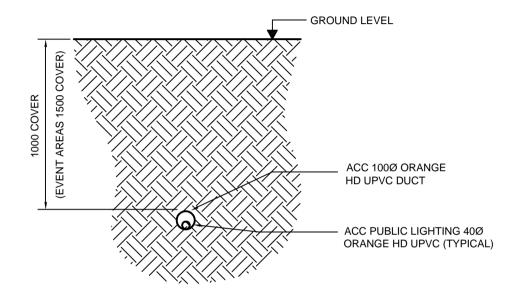

PARK LANDS - BORED

FOR PUBLIC LIGHTING UNDER OR ADJACENT TO PATHWAYS WHERE CABLE ROUTE IS CLEARLY DEFINED AND TRADITIONAL TRENCHING METHODS ARE NOT PRACTICAL AND/OR MAY CAUSE HARM TO EXISTING VEGETATION. FOR PREFERRED METHOD OF CABLE POSITIONING IN PARK LANDS, SEE STANDARD LT900-02 (Dwg C-ES-141-01).

NOTE

- 1 CO-ORDINATE DUCTING REQUIREMENTS WITH ALL SERVICE AUTHORITIES.
- 2 PERMANENT CABLE MARKERS REQUIRED AT MAXIMUM SPACING OF 30 METRES FOR LONG STRAIGHT ROUTES AND AT ANY CHANGE OF DIRECTION AND AT ANY ENDS OF CONDUIT/CABLE RUN.
- 3 EVENT AREAS 1500mm COVER.

DESIGNED TL	CHECKED TL		CONSTRUCTIO	N STANDARD	A DELAIDE	
DRAWN NS/JB	CERTIFIED RS		Lighting and Electrical		ADEL	UNCIL
	DATE 05/2001		BORED TI Park I			
C k int y projects	SCALE N.T.S.		raik		STANDARD NUMBER	SHEET No.
	DRWG No. C-ES-141-02	© COPYRIGHT This document produced by City of Adelaide shall not copied without written consent.			LT 900	03